


KEY MAP N.T.S.

GENERAL NOTES

- ALL WORKMANSHIP WILL BE TO THE STANDARDS OF LANDSCAPE ONTARIO.
- ALL PLANT MATERIAL TO BE NO. 1 GRADE NURSERY GROWN IN ACCORDANCE WITH THE CANADIAN STANDARDS FOR NURSERY STOCK, 6TH EDITION, 1998, BY THE CANADIAN NURSERY TRADES ASSOCIATION.
- BACKFILL WILL CONSIST OF SOIL NATIVE TO THE SITE OR GENERAL SOIL TYPE/CLASS NATIVE TO THE SITE. TOPSOIL TO BE TESTED FOR NUTRIENT VALUE, AND AMENDED FOR OPTIMAL GROWTH AS PER THE RECOMMENDATIONS OF THE SOIL TEST.
- CONTRACTOR SHALL MAINTAIN ALL LANDSCAPE AREAS UNTIL OWNER'S ACCEPTANCE OF PROJECT.
- CONTRACTOR TO LOCATE ALL UNDERGROUND UTILITIES.
- PLANTING MAY BE ADJUSTED TO SUIT LOCATIONS OF SITE UTILITY STRUCTURES/SERVICES.
- ALL MATERIALS MUST BE APPROVED BY LANDSCAPE ARCHITECT PRIOR TO INSTALLATION.
- SPREAD MULCH TO A MINIMUM OF 100mm COMPACTED DEPTH ON ALL TREE PITS.
- CHECK AND VERIFY ALL DIMENSIONS AND QUANTITIES PRIOR TO COMMENCEMENT OF WORK. ANY DISCREPANCIES ARE TO BE REPORTED IN WRITING TO THE LANDSCAPE ARCHITECT. QUANTITIES NOTED WITHIN THE PLAN SUPERCEDE THOSE IN THE PLANT LIST. ANY SUBSTITUTIONS SHALL BE APPROVED BY THE LANDSCAPE ARCHITECT.
- FINAL INSPECTION AND ACCEPTANCE OF PLANTING WORK SHALL COINCIDE WITH THE FINAL INSPECTION AND ACCEPTANCE OF ALL WORK INCLUDED IN THE CONTRACT.
- ALL SEEDED SLOPES 3:1 AND GREATER TO RECEIVE EROSION CONTROL MATTING (COIR MAT, OR OTHER WILDLIFE FRIENDLY ALTERNATIVE).
- SUBMIT A WRITTEN GUARANTEE TO THE EFFECT THAT ALL PLANTS ACCEPTED DURING THE PERIOD OF JANUARY 1st TO JULY 15th SHALL BE GUARANTEED UNTIL JULY 15th THE FOLLOWING YEAR. PLANTS ACCEPTED DURING THE PERIOD OF JULY 15th TO DECEMBER 31st SHALL BE GUARANTEED FOR ONE YEAR FROM THE DATE OF ACCEPTANCE. THE GUARANTEE PERIODS LISTED ABOVE SHALL APPLY TO ALL "NURSERY GROWN" PLANTS.
- AT THE TIME OF FINAL INSPECTION ALL PLANTS SHALL BE IN A HEALTHY, VIGOROUS GROWING CONDITION. PLANTED IN FULL ACCORDANCE WITH DRAWINGS AND CONDITIONS.
- DRAFT PLAN INFORMATION AS PER MHC.
- GRADING AND SERVICING INFORMATION AS PER MTE.
- TOPOGRAPHIC AND EXISTING CONDITIONS INFORMATION AS PER MTE.
- EXISTING TREE LOCATIONS AS PER NRSI. EIR AND TISP DATED JUNE 2019 AND ADDENDUM DATED OCTOBER 2019. EIR SOUTH RIVER ROAD SCOPED TREE INVENTORY AND SAVING REPORT DATED DECEMBER 11, 2019.

HAYLOCK FARM LTD.

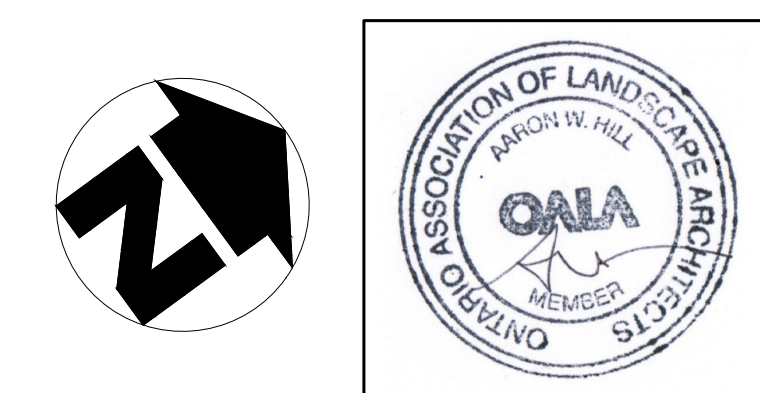

no.	date	description	by
1.	Mar 9 21	Issued for approval	CMH
2.	May 27 21	Revised as per engineering	CMH

HAYLOCK SUBDIVISION
Block 141
Township of Centre Wellington
Village of Elora
Landscape Plan




PROJECT NO.: 2019-10 DRAWN BY: AWH

SCALE: 1:200 DESIGNED BY: CMH


SHEET: APPROVED BY: AWH

L1

PLOT DATE: MAY 27, 2020

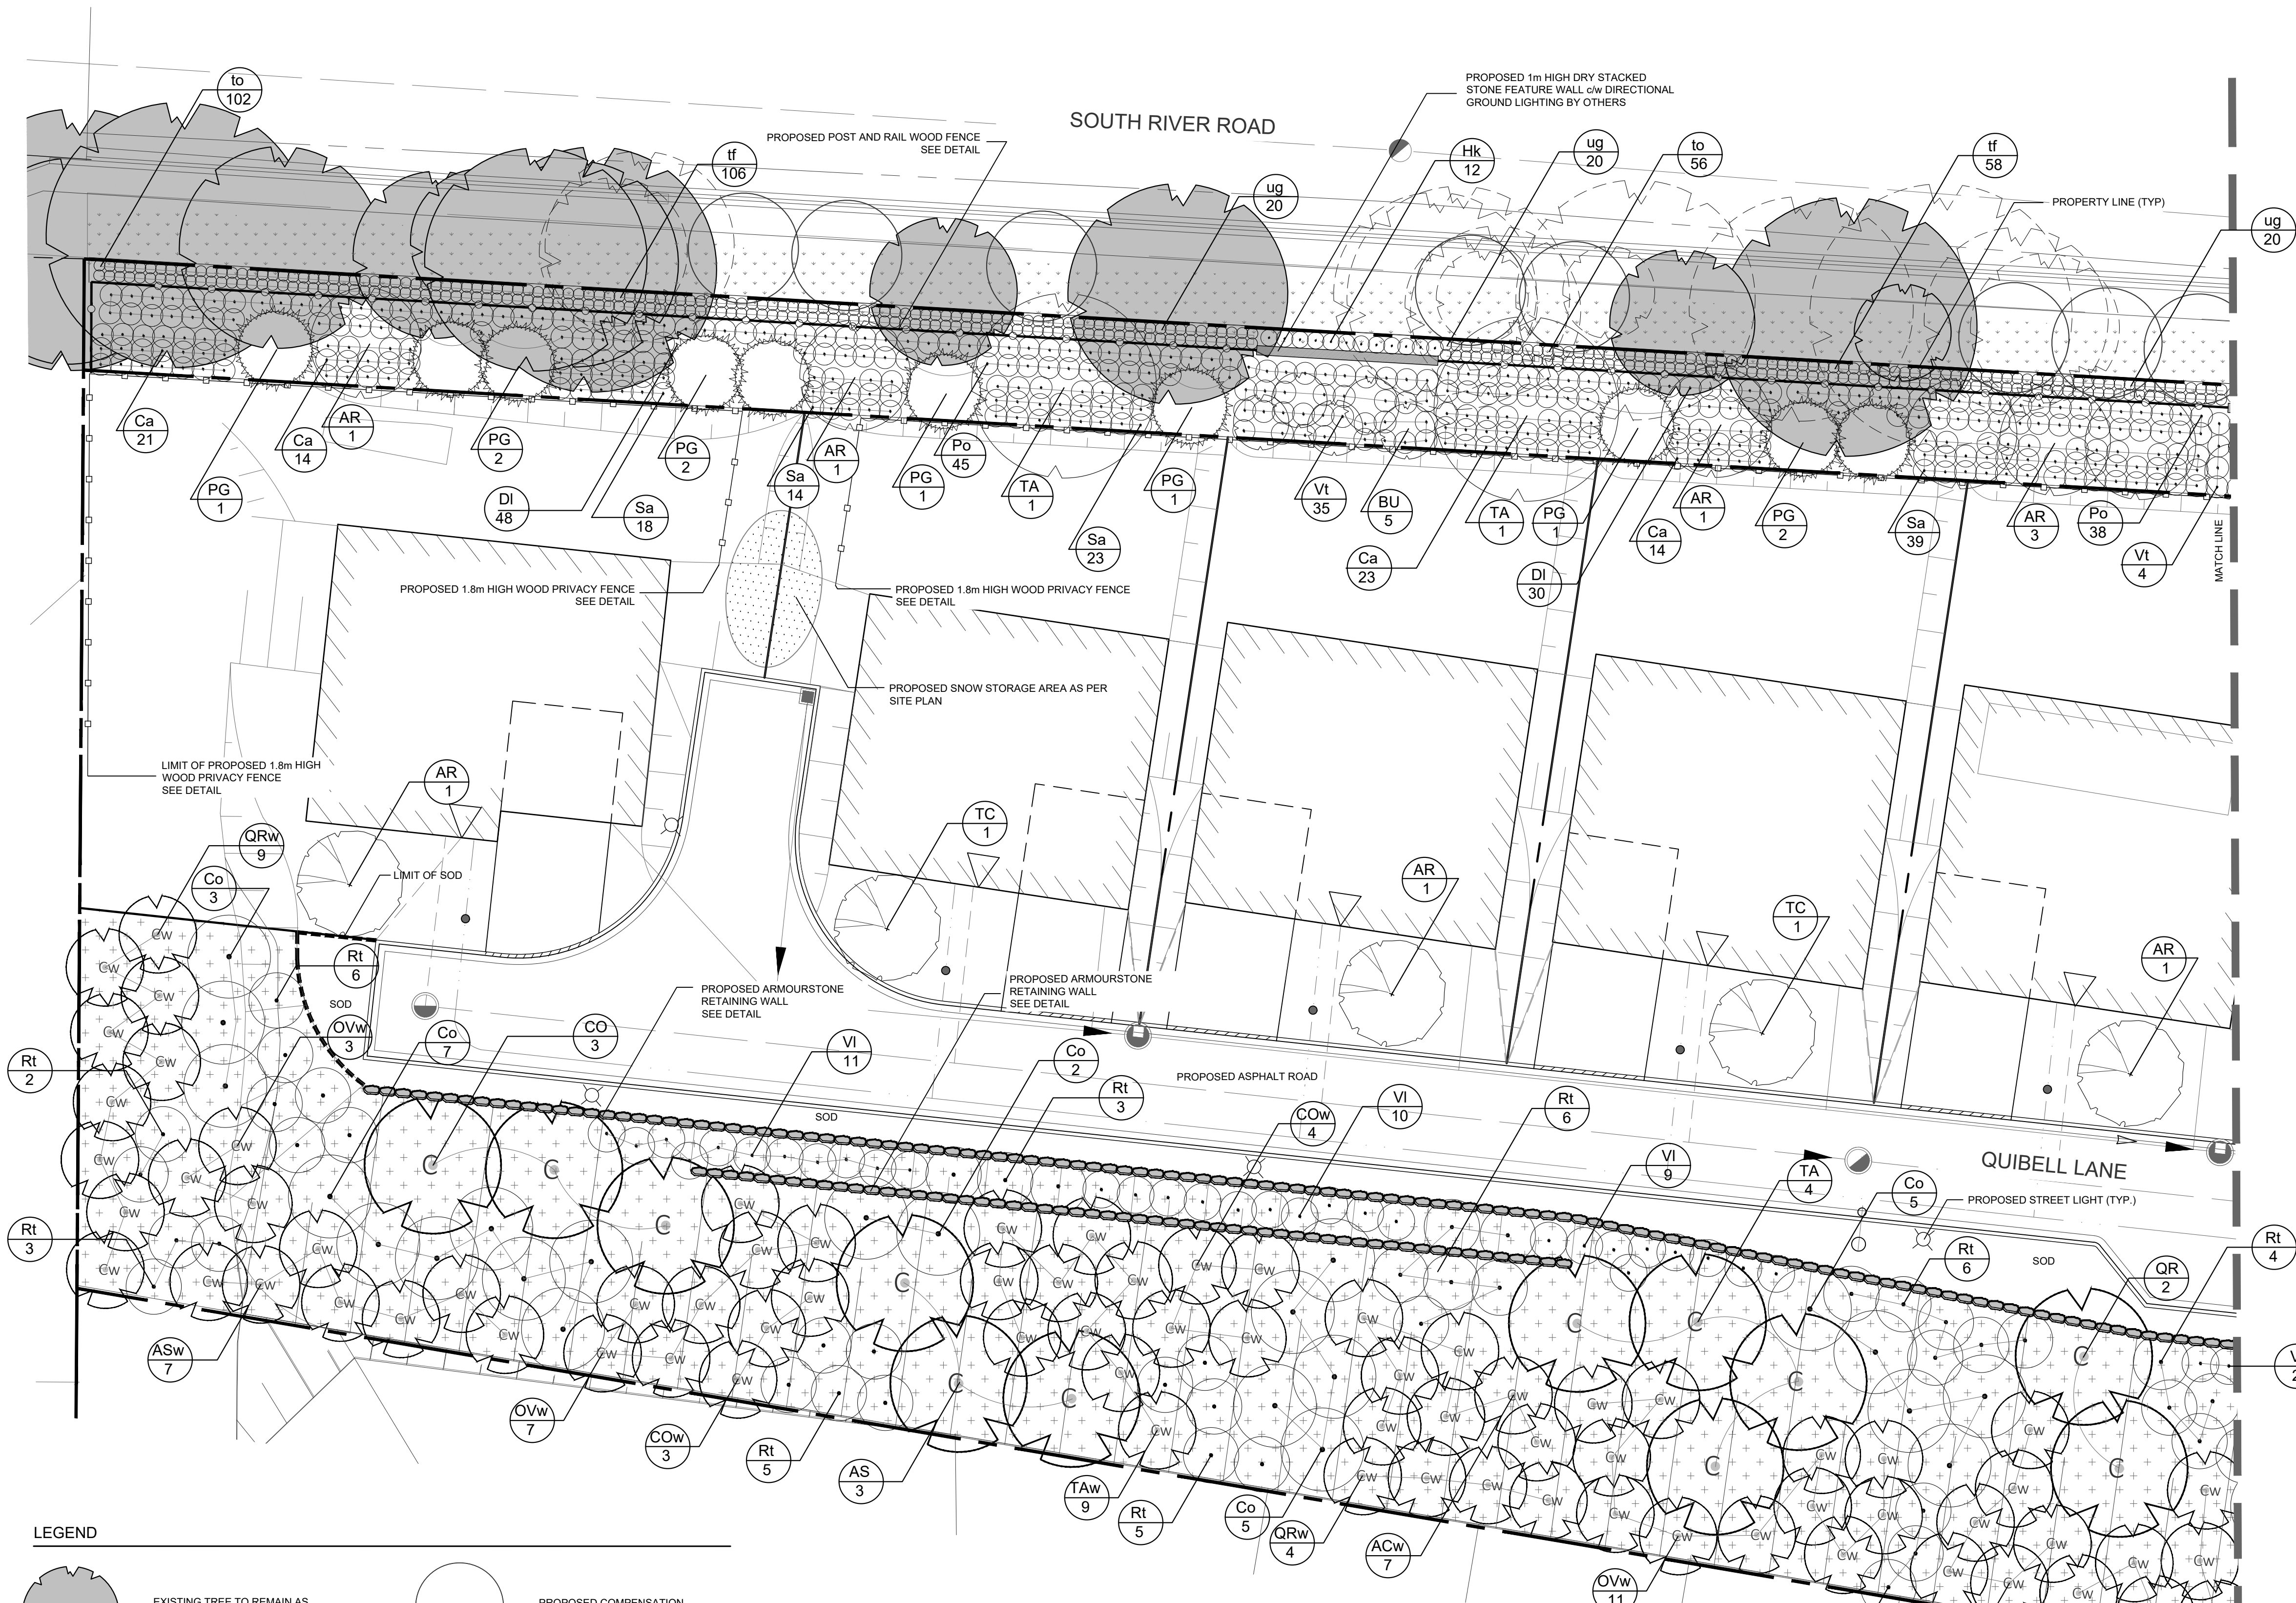

LEGEND

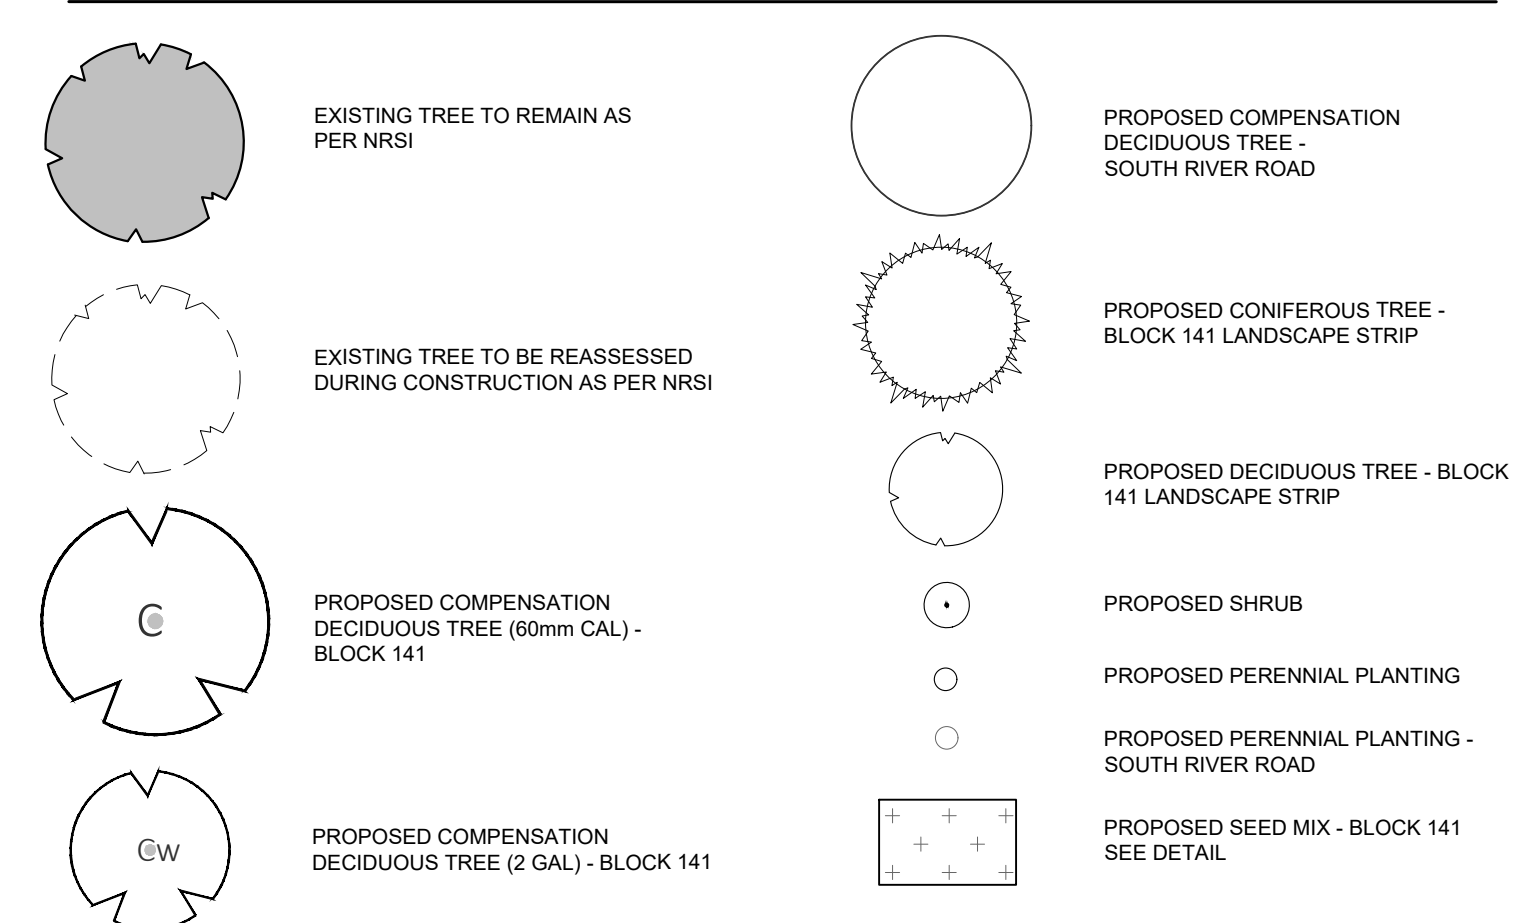


BLOCK 141 PLANT MATERIAL LIST


KEY	QUANT.	BOTANICAL NAME	COMMON NAME	SIZE	COND.
AR	9	Acer rubrum Redpointe	Redpointe Maple	60mm cal.	W.B.
BU	5	Betula utilis var. jacquemontii	Jacquemontii Birch	60mm cal.	W.B.
PG	10	Picea glauca	White Spruce	250cm ht.	W.B.
TA	2	Tilia americana	Basswood	60mm cal.	W.B.
TC	2	Tilia cordata 'Redmond'	Redmond Linden	60mm cal.	W.B.
Ca	58	Ceanothus americanus	New Jersey Tea	50cm, 3 gal.	Pot
Co	22	Cornus alternifolia	Pagoda Dogwood	50cm, 3 gal.	Pot
DI	78	Diervilla lonicera	Bush Honeysuckle	50cm, 3 gal.	Pot
Hk	12	Hypericum kalmianum	Pot O' Gold St. John's Wort	50cm, 3 gal.	Pot
Po	83	Physocarpus opulifolius 'Tiny Wine'	Tiny Wine Ninebark	50cm, 3 gal.	Pot
Rt	43	Rhus typhina	Staghorn Sumac	50cm, 3 gal.	Pot
Sa	94	Symphoricarpos albus	Snowberry	50cm, 3 gal.	Pot
Vi	32	Viburnum lantana	Wayfaring Tree	50cm, 3 gal.	Pot
Vt	39	Viburnum trilobum 'Compactum'	Dwarf American Cranberry	50cm, 3 gal.	Pot
if	164	Tradescantia ohioensis	Ohio Spiderwort	1 gal.	Pot
to	158	Tricyrtis formosana 'Autumn Glow'	Autumn Glow Toadlily	1 gal.	Pot
ug	60	Uvularia grandiflora	Large-flowered Bellwort	1 gal.	Pot

BLOCK 141 COMPENSATION PLANT MATERIAL LIST


KEY	QUANT.	BOTANICAL NAME	COMMON NAME	SIZE	COND.
COMPENSATION TREES - 60mm CAL.					
AS	3	Acer saccharum	Sugar Maple	60mm cal.	W.B.
CO	3	Celtis occidentalis	Common Hackberry	60mm cal.	W.B.
QR	2	Quercus rubrum	Red Oak	60mm cal.	W.B.
TA	4	Tilia americana	Basswood	60mm cal.	W.B.
COMPENSATION TREES - 2 GAL.					
ACw	13	Acer rubrum	Red Maple	2 gal.	Pot
ASw	7	Acer saccharum	Sugar Maple	2 gal.	Pot
COw	7	Celtis occidentalis	Common Hackberry	2 gal.	Pot
OVw	21	Ostrya virginiana	Ironwood	2 gal.	Pot
QRw	13	Quercus rubrum	Red Oak	2 gal.	Pot
TAW	15	Tilia americana	Basswood	2 gal.	Pot

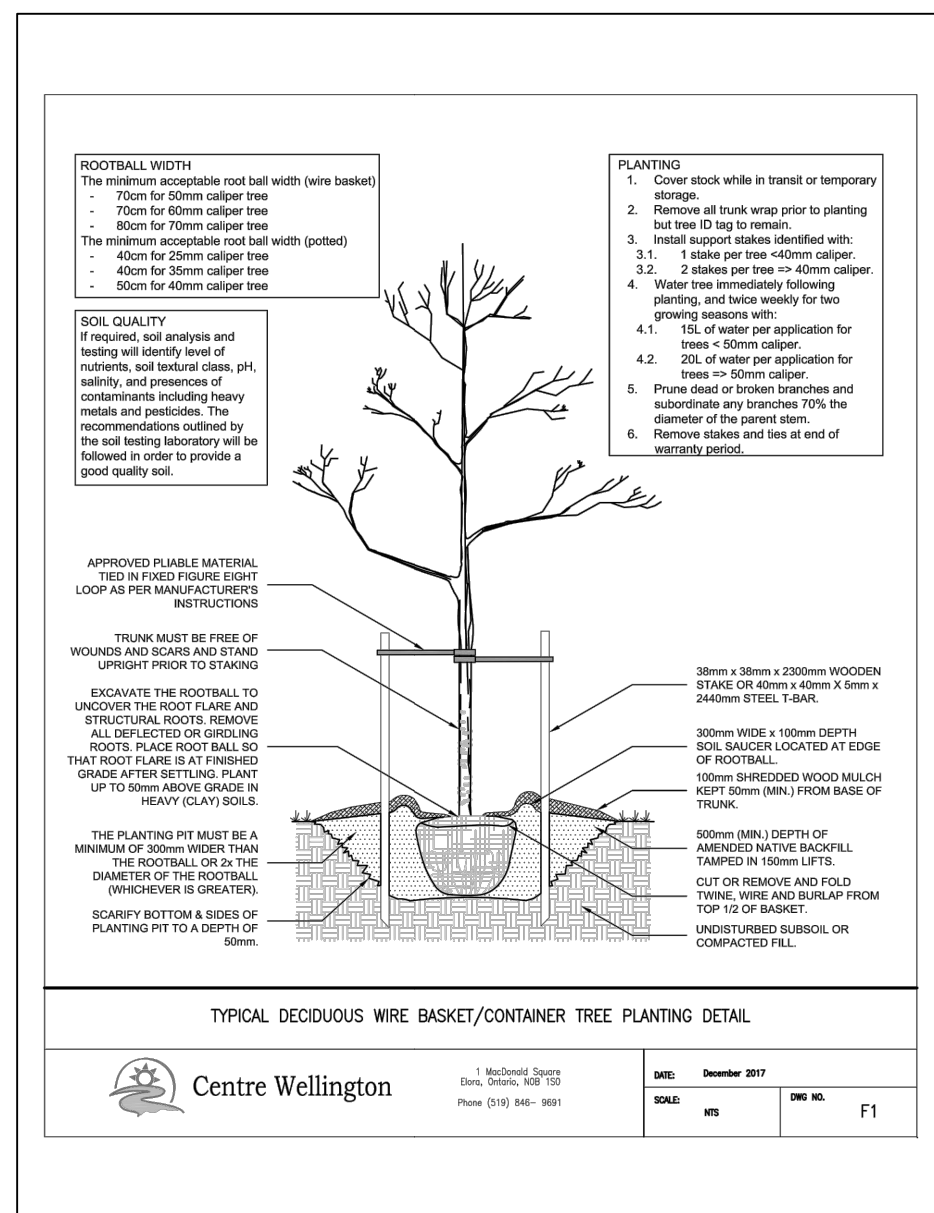



1 CENTRE WELLINGTON STANDARD DECIDUOUS TREE PLANTING DETAIL NTS

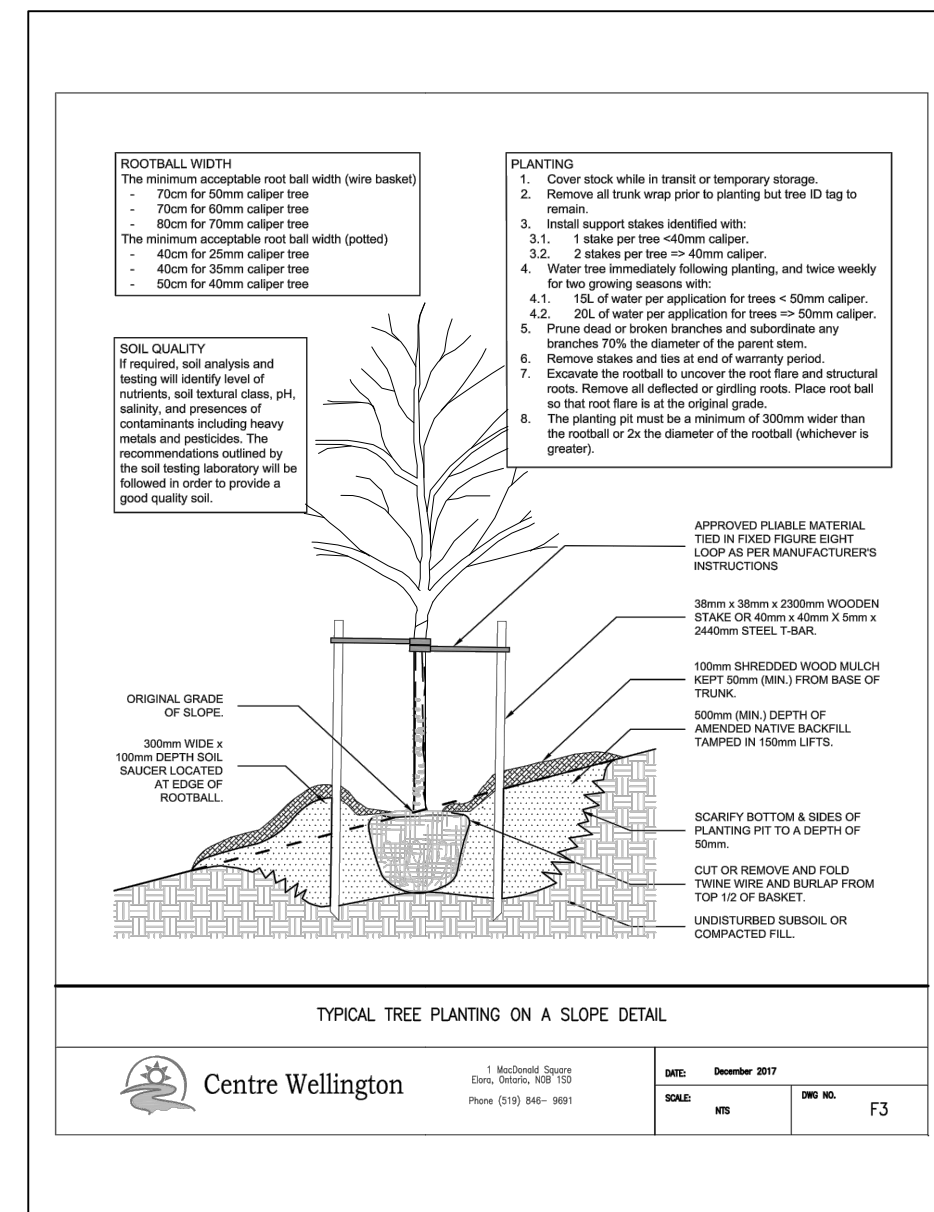

2 CENTRE WELLINGTON STANDARD TREE PLANTING ON A SLOPE DETAIL NTS

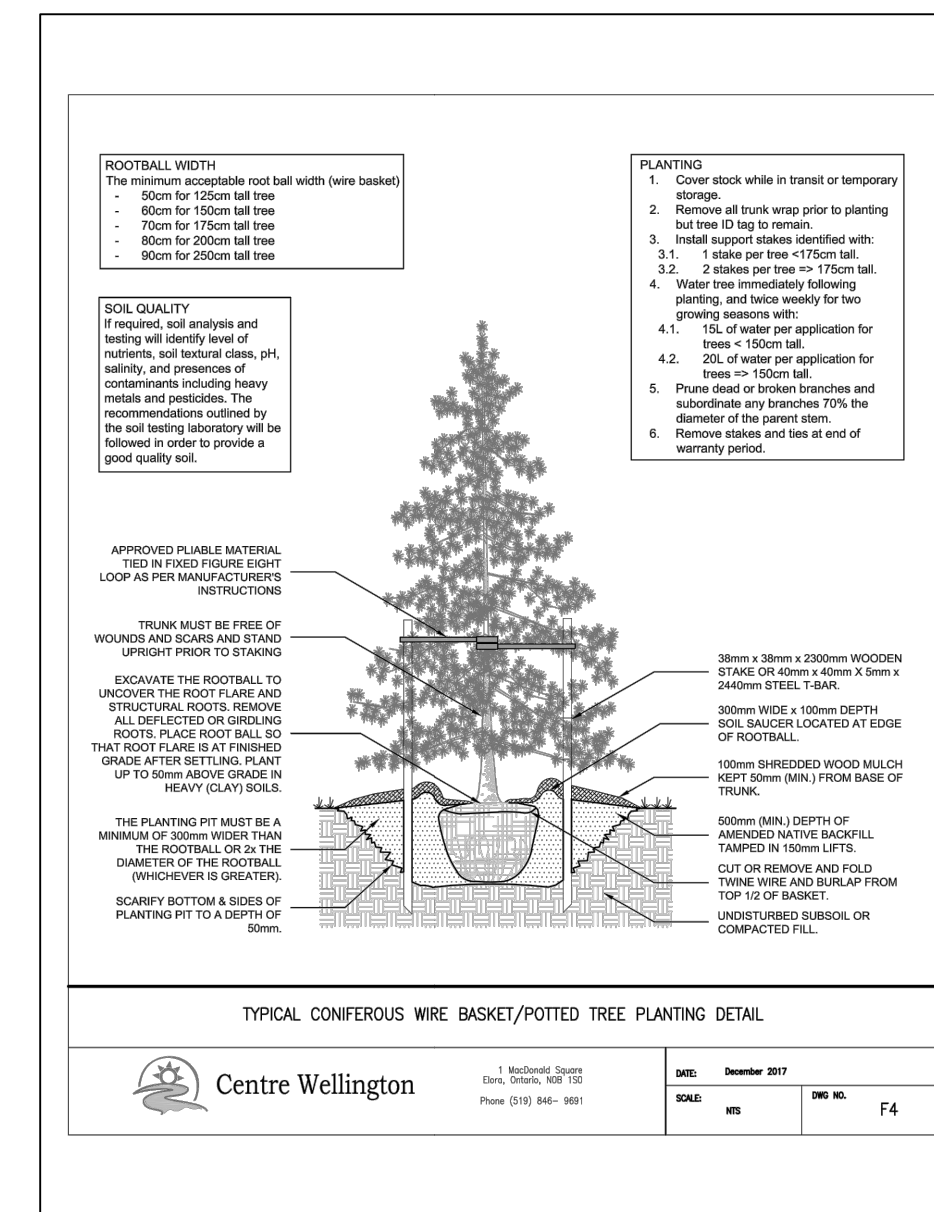


3 CENTRE WELLINGTON STANDARD CONIFEROUS TREE PLANTING DETAIL NTS

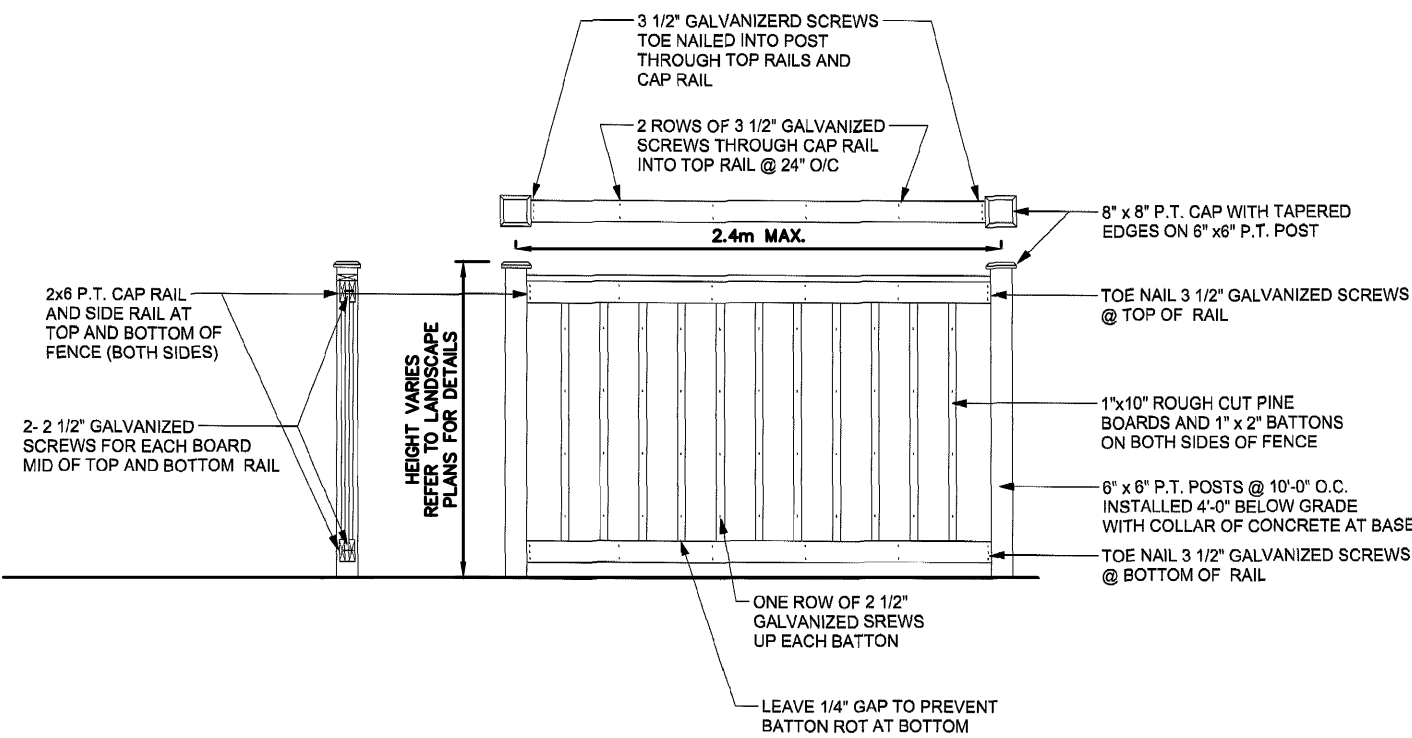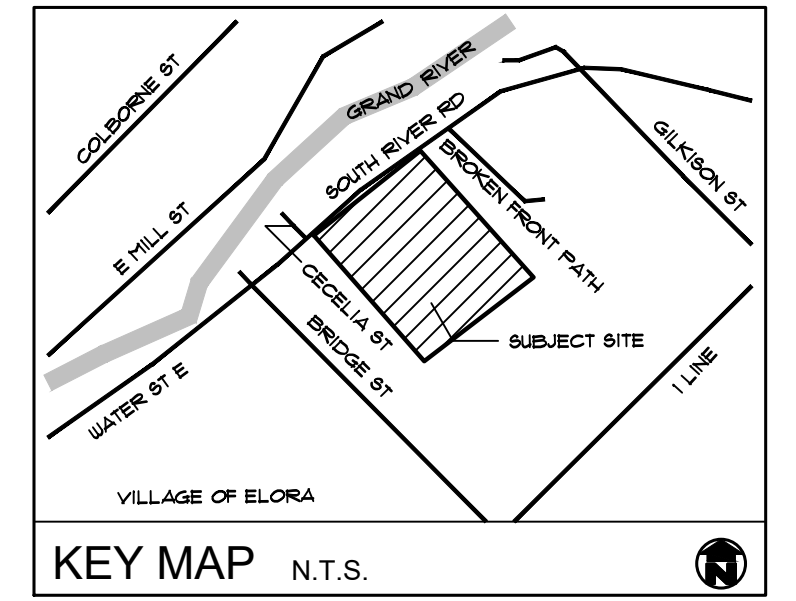


4 BOARD FENCE DETAIL NTS




5 DRY STACKED STONE FEATURE WALL DETAIL NTS

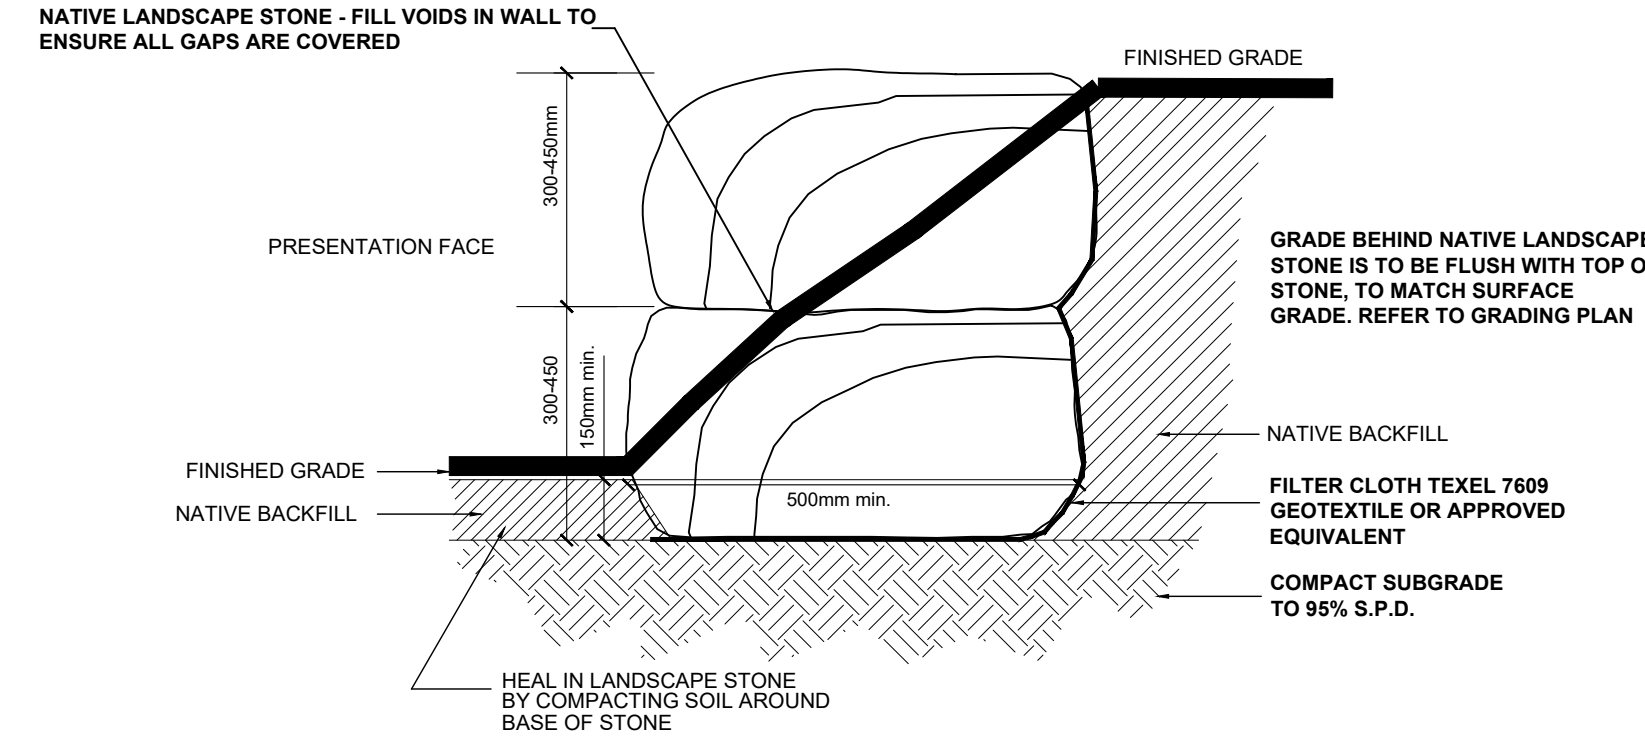

6 TYPICAL ARMOURSTONE RETAINING WALL DETAIL NTS

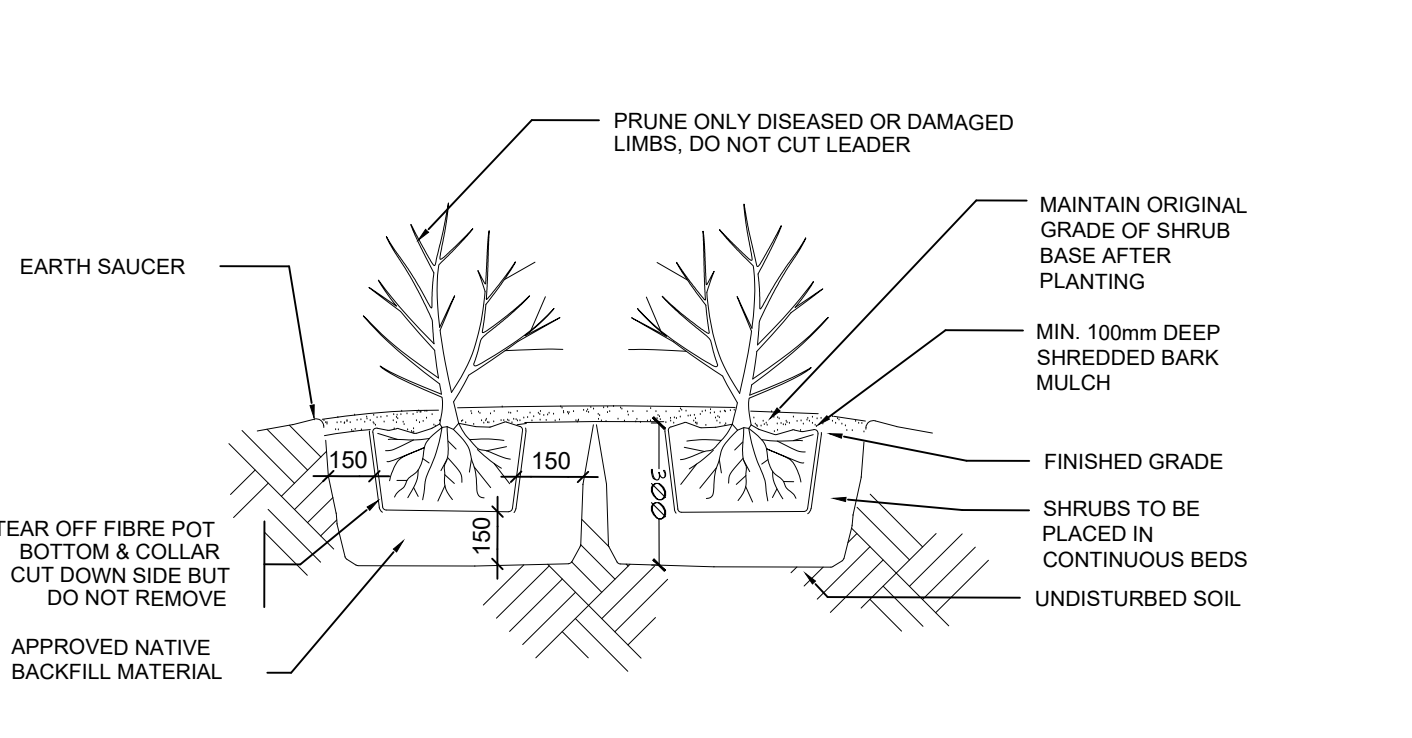

7 SHRUB PLANTING DETAIL NTS

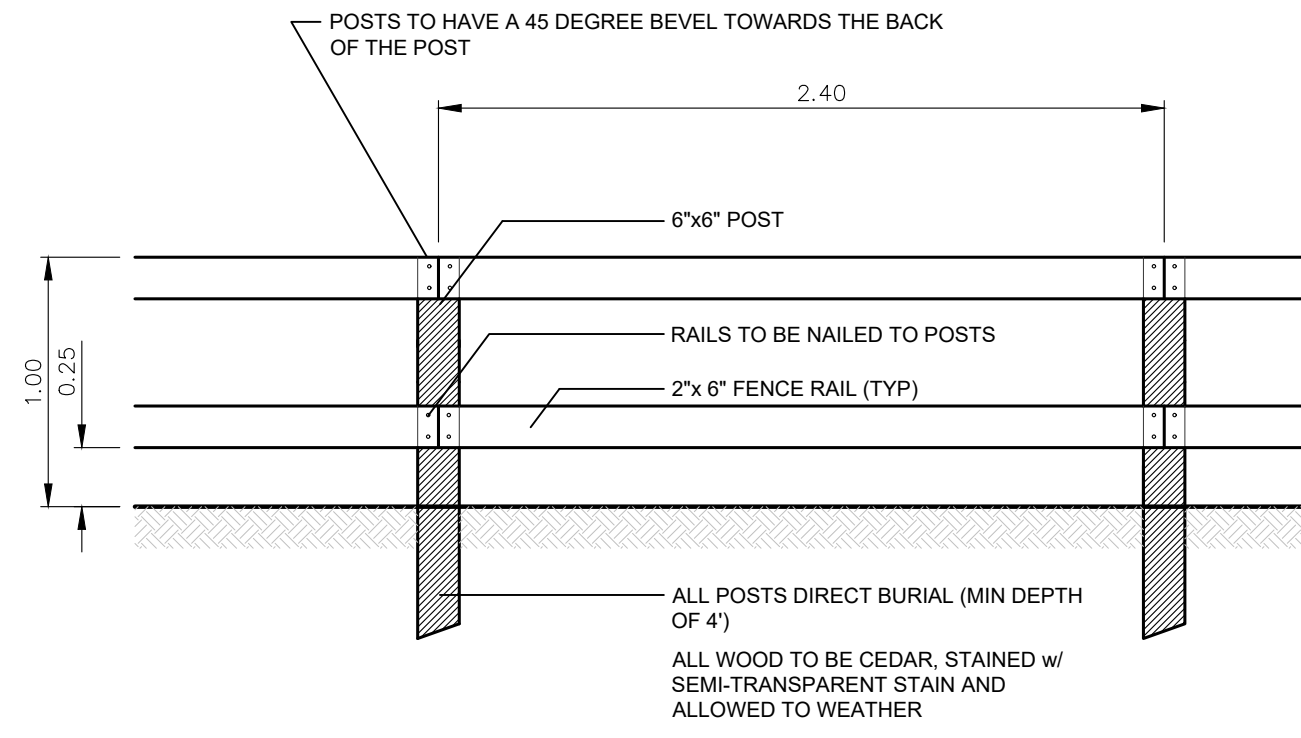

8 1.0m HIGH POST AND RAIL FENCE NTS

HYDROSEED FOR SLOPE STABILIZATION

WOODLAND NATIVE SEED MIX (OSC #827E)

10%	FOXTAIL BEARDTONGUE (PENSTEMON DIGITALIS)
1%	BEBB'S SEDGE (CAREX BEBBII)
1%	NODDING-FRINGED SEDGE (CAREX CRINATA)
50%	FOWL BLUEGRASS (POA PALUSTRIS)
30%	SHOWY TICK TREF OIL (DESMODIUM CANADENSIS)
1%	FOWL MANNAGRASS (GLYCERIA STRIATA)
2%	SPOTTED JOE PEEWEED (EUPATORIUM MACULATUM)
1%	CANADA ANEMONE (ANEMONE CANADENSIS)
4%	WHITE AVENS (GEUM CANADENSE)

TO BE APPLIED AT A RATE OF 25kg/ha

ANNUAL RYE GRASS (NURSE CROP)

TO BE APPLIED AT A RATE OF 22kg/ha

NOTE: HYDROSEED MIXES AS PER OSC (PHONE) 1-800-465-5849

FINE GRADE AND SEED ALL DISTURBED AREAS WITHIN 30 DAYS WITH BOTH THE WOODLAND NATIVE SEED MIX AND THE ANNUAL RYE GRASS AT THE RATES LISTED.

NOTE: SLOPES 3:1 AND GREATER TO RECEIVE EROSION CONTROL MATTING AT THE DIRECTION OF THE LANDSCAPE ARCHITECT.

HAYLOCK FARM LTD.



REVISIONS

no.	date	description	by
1.	Mar 9 21	Issued for approval	CMH
2.	May 27 21	Revised as per engineering	CMH

HAYLOCK SUBDIVISION
Block 141
Township of Centre Wellington
Village of Elora
Landscape Details



PROJECT NO.: 2019-10	DRAWN BY: AWH
SCALE: N.T.S.	DESIGNED BY: CMH
SHEET: L3	APPROVED BY: AWH
	PLOT DATE: MAY 27, 2020