
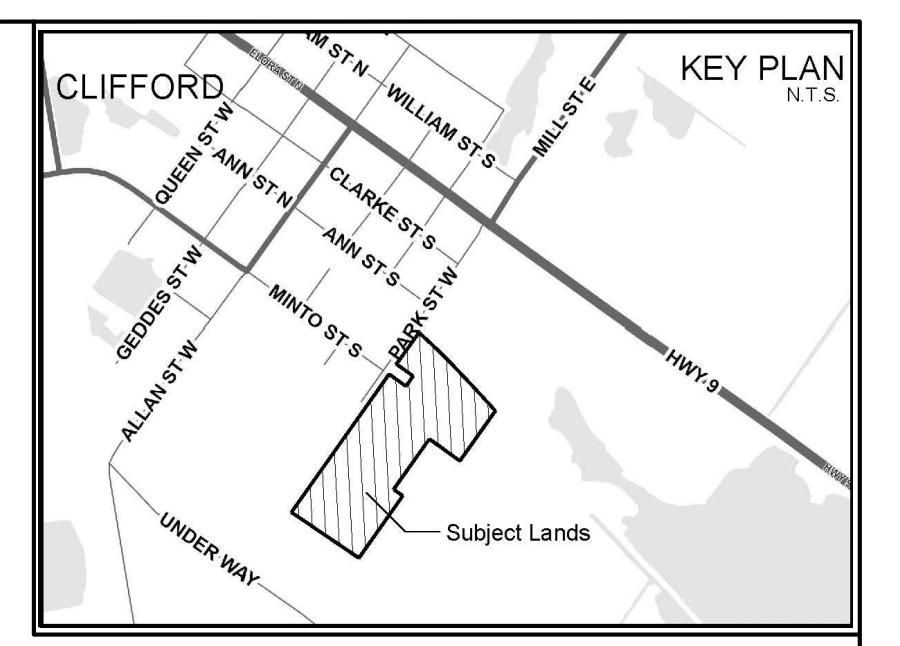


- GENERAL NOTES:**
- QUALIFIED PERSONS AND PROTOCOLS ARE TO PROVIDE CONFIRMATION/SUPERVISION ON SITE TO ENSURE THAT ONLY TESTED/ACCEPTABLE MATERIAL IS BEING RECEIVED.
 - FILL BEING BROUGHT TO SITE IS TO BE FROM A LICENSED PIT AND/OR MEET TABLE 2 OF THE SOIL, GROUND WATER AND SEDIMENT STANDARDS FOR USE UNDER PART XV.1 OF THE ENVIRONMENTAL PROTECTION ACT.
 - ANY DISTURBED AREAS THAT REMAIN INACTIVE FOR MORE THAN 90 DAYS ARE TO BE STABILIZED WITH TOPSOIL AND VEGETATION.
- NOTES:**
- EROSION AND SEDIMENT CONTROL (ESC) PLAN IS A DYNAMIC DOCUMENT, WHICH MAY BE SUBJECT TO CHANGE OR MODIFICATIONS AS A RESULT OF SITE DEVELOPMENTS OR CHANGES ON SITE. ANY DEVIATION FROM APPROVED PLANS MUST BE DESIGNED BY A QUALIFIED PROFESSIONAL.
 - IT IS EVERYONE'S RESPONSIBILITY TO PREVENT CONSTRUCTION RELATED SEDIMENT FROM IMPACTING AQUATIC RESOURCES AND OTHER NATURAL FEATURES.
 - PLEASE REFER TO ESC GUIDELINE FOR URBAN CONSTRUCTION (DECEMBER 2008) FOR THE DESIGN AND DESIGN ALTERATION OF ESC.
 - NO PUMPING OF SEDIMENT LADEN RUNOFF FROM CONSTRUCTION AREA TO THE WETLAND/REGULATED FEATURE IS ALLOWED AT ANY TIME.
 - AN AFTER-HOURS CONTACT NUMBER IS TO BE VISIBLY POSTED ON-SITE FOR EMERGENCIES. ALL THE PLANS SHOULD HAVE NAME AND CONTACT INFO OF THE PERSON RESPONSIBLE FOR ESC MEASURES.
 - ANY SEDIMENT SPILL FROM THE SITE SHOULD BE REPORTED TO MINISTRY OF ENVIRONMENTAL (SPILL ACTION CENTER) AT 1-800-268-6060.
 - EROSION AND SEDIMENT CONTROL MEASURES ARE TO BE EVALUATED ON A WEEKLY BASIS AND AFTER ANY STORM EVENT. ANY REPAIRS REQUIRED ARE TO BE RECTIFIED WITHIN 48HR.
 - PERIMETER FENCING ALONG NORTH WEST EAST AND SOUTH SIDE OF SITE TO BE EXTENDED TO MINIMIZE IMPACT ON EXISTING RESIDENCES.
 - IN THE EVENT OF HIGH WINDS, EARTHWORKS WILL BE SUSPENDED AND CONTRACTOR WILL BE REQUIRED TO CONFINE ALL ACTIVITIES TO DUST CONTROL UNTIL FURTHER NOTICE. THE TOWN WILL DETERMINE WHEN THE CONDITION WILL BE INVOKED.
 - PRIOR TO ANY WORK BEGINNING ON THE SITE, THE CONTRACTOR WILL CALL TOWN OF MINTO TO ARRANGE A PRE-START UP MEETING TO REVIEW THE CONSTRUCTION PLAN. SEDIMENT AND EROSION CONTROL MAY BEGIN AFTER THAT TIME AS DIRECTED BY THE TOWN. SERVICING AND OTHER WORK WILL NOT BEGIN UNTIL THE TOWN HAS INSPECTED AND APPROVED ALL SEDIMENT AND EROSION CONTROL MEASURES ON AND OFF THE SITE. MEASURES WILL INCLUDE THOSE SHOWN ON THE PLAN AS WELL AS A STREET SWEEPING PROGRAM AND ANY DIRECTION THAT MAY BE PROVIDED BY THE TOWN AT THAT TIME.
 - QUALIFIED PERSONS AND PROTOCOLS ARE TO PROVIDE CONFIRMATION /SUPERVISION ON SITE TO ENSURE THAT ONLY TESTED/ACCEPTABLE MATERIAL IS BEING RECEIVED.
 - FILL BEING BROUGHT TO SITE IS TO BE FROM A LICENSED PIT AND/OR MEET TABLE 2 OF THE SOIL, GROUND WATER AND SEDIMENT STANDARDS FOR USE UNDER PART XV.1 OF THE ENVIRONMENTAL PROTECTION ACT.
 - ANY DISTURBED AREAS THAT REMAIN INACTIVE FOR MORE THAN 90 DAYS ARE TO BE STABILIZED WITH TOPSOIL AND VEGETATION.

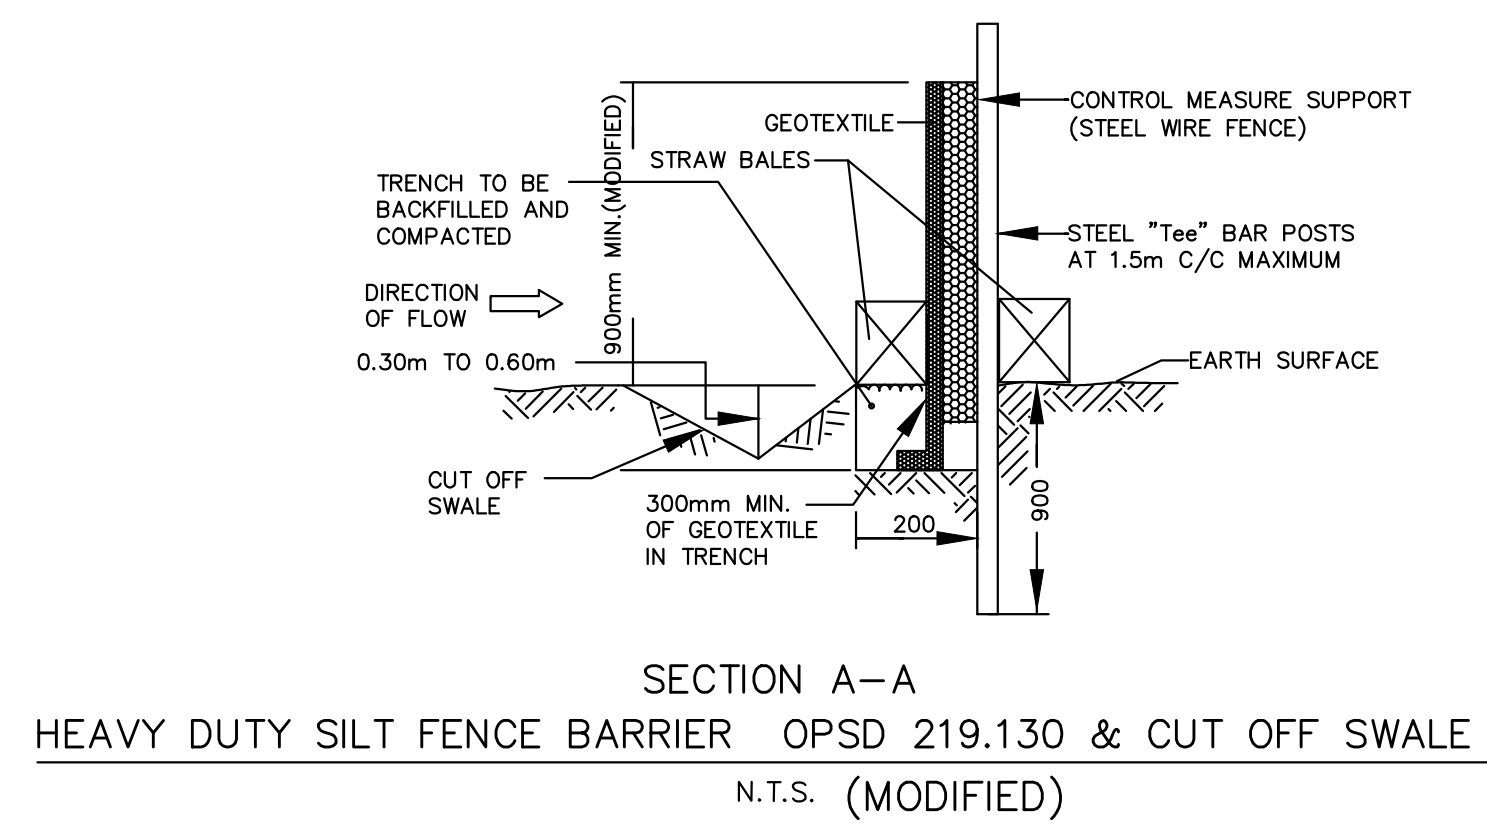

SUBMISSIONS: 1st ___ 2nd <u>V</u> 3rd ___ INTERIM ___	
DATE: <u>MARCH/25</u> Final ___	
2025.03.27	ISSUED FOR FSR SUBMISSION
2024.06.24	ISSUED FOR FSR SUBMISSION
DATE	DETAILS
ELEVATION NOTE	
ELEVATIONS ARE OF GEODETIC ORIGIN (CGVD-1928/78), AND ARE DERIVED FROM GNSS OBSERVATIONS AND NATURAL RESOURCES CANADA'S GEOD MODEL HT2.0.	
	REVIEWED BY
DESIGNED BY ANDRZEJ JAWORSKI P.Eng. CONSULTING ENGINEER	DATE
DIRECTOR OF PUBLIC WORKS	
Urbtech Engineering Inc. 1200 Speers Road, Suite 8, Oakville, Ontario, L6L 2X4 Telephone: 905 896 7364	
CLIFFORD (PARK STREET) DEVELOPMENTS INC. 41 PARK STREET WEST TOWN OF MINTO	
TOWN OF MINTO	
DRAWING NAME:	
EROSION & SEDIMENT CONTROL DETAILS	
SCALE: AS NOTED	AREA: MINTO
DRAWN BY: G.J.	CHECKED BY: A.J.
PROJECT No.: 22-471	PLAN No.: SN1